

PARSONS BRINCKERHOFF, INC. 6015 W. ST. JOSEPH, SUITE 101
LANSING, MICHIGAN 48917
517-886-7416

Michigan Department of Transportation

 VICINITY MAP

 DATE
 SCALE
 CONT. SEC.
 JOB NO.
 DESIGN UNIT R.O. W CONST.
 SHEET NO. R.O. W CONST.

 07/10/06
 1"=1000'
 20014
 86806A
 RUPINSKI
 2 0F 13

ENGINEERING REPORT NO	ENVIRON IMPACT STMT	
METHOD OF SURVEY		YEAR
SURVEY ORDER	SURVEY CHIEF	YEAR
AERIAL SURVEY NO N/A		YEAR
HORIZ DATUM	VERT DATUM	
ROAD DESIGN INITIATED Sep 2005	COMPLETED	
	·	

FIELD INSPECTION (GI) BY TOM VANDENBERG FHWA ARFA ENGINEER

# GENERAL PLAN NOTES

# UNDERGROUND UTILITIES

FOR PROTECTION OF UNDERGROUND UTILITIES AND IN CONFORMANCE WITH PUBLIC ACT 53, 1974, THE CONTRACTOR SHALL DIAL 1-800-482-7171 A MINIMUM OF THREE FULL WORKING DAYS, EXCLUDING SATURDAYS, SUNDAYS, AND HOLIDAYS PRIOR TO BEGINNING EACH EXCAVATION IN AREAS WHERE PUBLIC UTILITIES HAVE NOT BEEN PREVIOUSLY LOCATED. MEMBERS WILL THUS BE ROUTINELY NOTIFIED. THIS DOES NOT RELIEVE THE CONTRACTOR OF THE RESPONSIBILITY OF NOTIFYING UTILITY OWNERS WHO MAY NOT BE A PART OF THE "MISS DIG" ALERT SYSTEM.

### OLD PLANS

THE FOLLOWING OLD PLANS WERE REFERRED TO IN THE DESIGN OF THIS PROJECT.
MICHIGAN PROJECT EBF 171 (14)
MICHIGAN PROJECT IM 9920 (001)
MICHIGAN PROJECT IM 75-4 (082) 250

IN ADDITION, OTHER OLD PLANS THAT PREDATE THIS PROJECT MAY BE AVAILABLE. THESE PLANS MAY BE REVIEWED IN THE TRANSPORTATION SERVICE CENTER DURING NORMAL WORKING HOURS.

### STATIONING

STATIONING ON THIS PROJECT WAS TAKEN FROM OLD PLANS AND PAVEMENT STENCILED STATIONING AND IS NOT NECESSARILY ACCURATE.

### SLOPES

CLASS A SLOPES SHALL BE REQUIRED ON THIS PROJECT.

# SOIL BORINGS AND/OR PAVEMENT CORES

THE SOIL BORING LOGS AND/OR PAVEMENT CORES REPRESENT POINT INFORMATION. NO INFERENCE SHOULD BE MADE THAT SUBSURFACE OR PAVEMENT CONDITIONS ARE THE SAME AT OTHER LOCATIONS.

# PERMANENT SIGNS

ANY PERMANENT SIGNS REQUIRING RELOCATION DUE TO CONTRACTOR OPERATIONS SHALL BE SALVAGED AND RESET BY THE CONTRACTOR AT LOCATIONS DESIGNATED BY THE ENGINEER. SIGNS AND POSTS DAMAGED DURING THE REMOVAL AND STORAGE OPERATIONS SHALL BE REPLACED WITH NEW SIGNS AND POSTS. THE COST OF THIS WORK SHALL BE BORNE BY THE CONTRACTOR.

# RECREATIONAL PROPERTIES

THE CONTRACTOR SHALL NOT PARK ANY VEHICLES OR STORE ANY EQUIPMENT ON ANY PUBLIC RECREATIONAL PROPERTY. ACCESS TO THE RECREATIONAL SITE MUST BE MAINTAINED AT ALL TIMES.

# SEED MIXTURE

THE SYMBOL FOR THE PERMANENT TURF SEED MIXTURE ON THIS PROJECT IS SYMBOL

# UTILITIES

THE EXISTING UTILITIES LISTED BELOW AND SHOWN ON THESE PLANS REPRESENT THE BEST INFORMATION AVAILABLE. THIS INFORMATION DOES NOT RELIEVE THE CONTRACTOR OF THE RESPONSIBILITY TO BE SATISFIED AS TO ITS ACCURACY AND THE LOCATION OF EXISTING UTILITIES.

NAME OF OWNER

KIND OF UTILITY

ELECTRIC

TELEPHONE

GAS/DIST.

CHARTER COMMUNICATIONS CABLE TV
ATTN: TED MATTHEWS
P.O. BOX 339

OSCODA, MI 4875Ø PHONE: (989) 739-6352 CONSUMERS ENERGY

CONSUMERS ENERGY ELECTRIC DISTRIBUTION ATTN: GREGORY MORTENSEN

ATTN: GREGORY MORTENSEN 821 HASTING ST TRAVERSE CITY, MI 49686 PHONE: (231) 929-6242

VERIZON COMMUNICATIONS ATTN: ROBIN WILLIAMS 3249 FOREST DR GAYLORD, MI 49735 PHONE: (989) 732-8503

MICHCON GAS COMPANY DISTRIBUTION ATTN: DAVID NEWCOMBE 609 BJORNSON ST BIG RAPIDS, MI 49307 PHONE: (231) 592-3244

# NOTES APPLYIING TO STANDARD PLANS

WHERE THE FOLLOWING ITEMS ARE CALLED FOR ON PLANS, THEY ARE TO BE CONSTRUCTED ACCORDING TO THE STANDARD PLAN GIVEN BELOW OPPOSITE EACH ITEM UNLESS OTHERWISE INDICATED.

SOIL EROSION & SEDIMENTATION CONTROL MEASURES R-96-C

SODDING, SEEDING, AND TREE PLANTING R-100-D

TEMPORARY TRAFFIC CONTROL DEVICES R-125-D•

\* DENOTES SPECIAL DETAIL

# MISCELLANEOUS ESTIMATES

THE FOLLOWING ITEMS OF WORK SHALL BE DONE AS THEY APPLY THROUGHOUT THE PROJECT. THESE ITEMS ARE NOT DETAILED OR INCLUDED ON THE PLAN AND PROFILE SHEETS:

PAY ITEM

200 Ft Erosion Control, Silt Fence 278 Syd Slope Restoration, Type A 278 Syd Slope Restoration, Type B

THE FOLLOWING ITEMS OF WORK ARE ESTIMATED FOR THE ENTIRE PROJECT TO MAINTAIN TRAFFIC ON THE JOB SITE DURING CONSTRUCTION.


AY ITEM







	NOTE	S
DATE	CONT. SEC.	


07/10/06

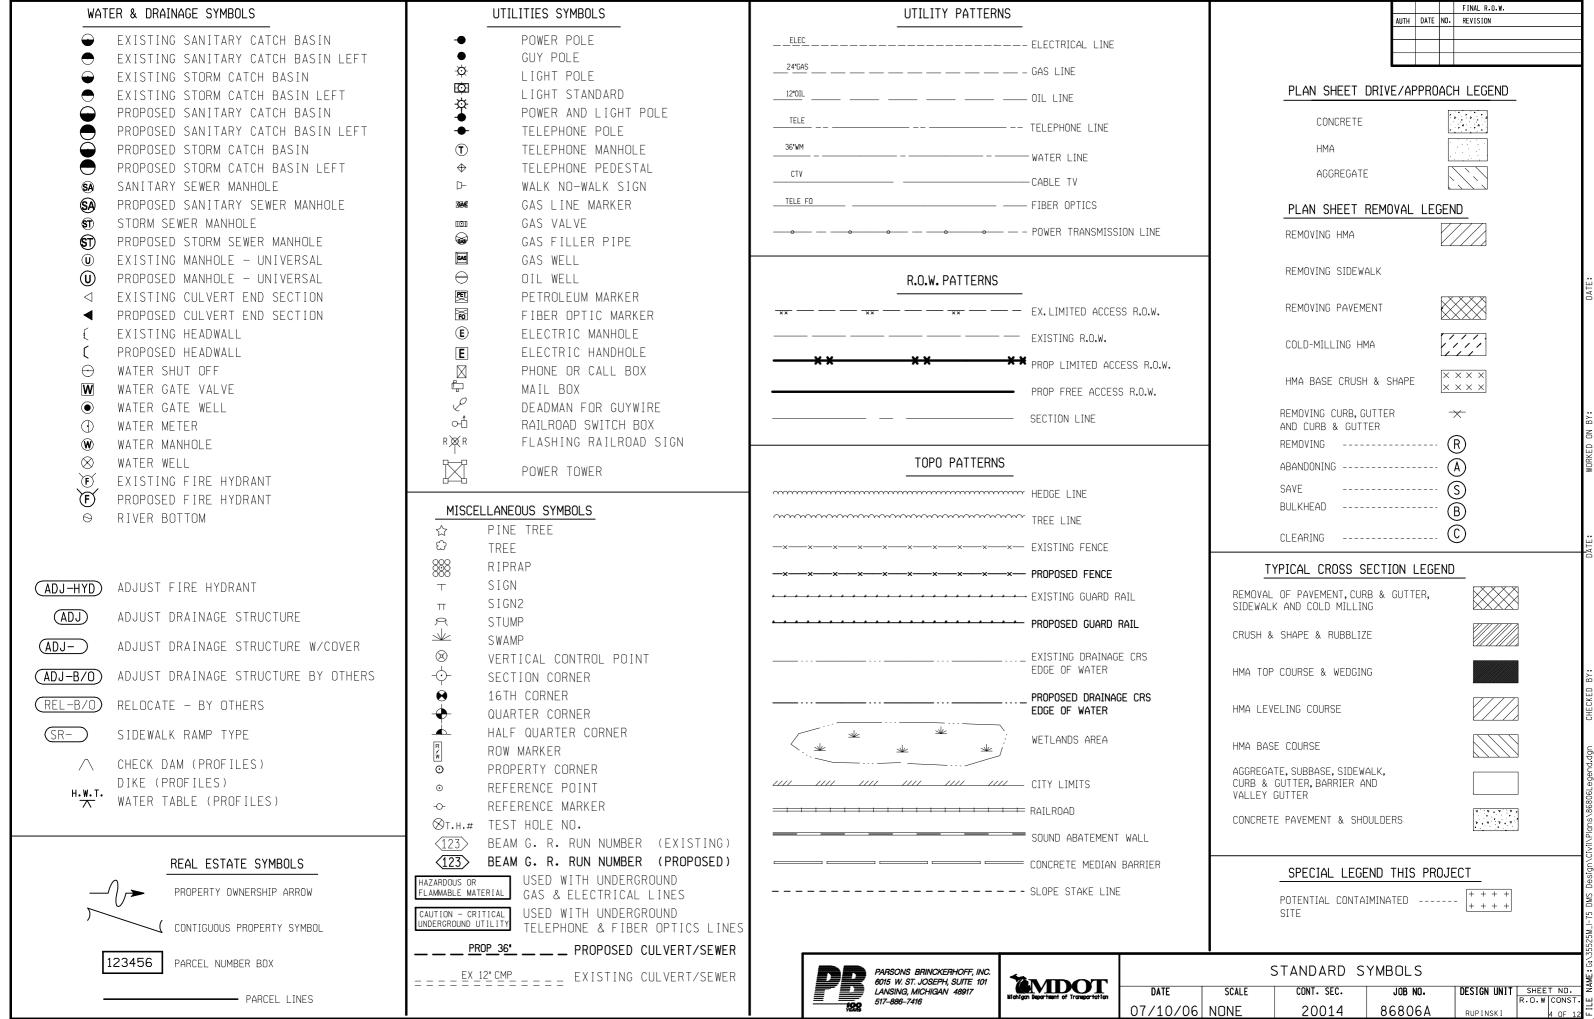



FINAL R.O.W. CONTRACTOR TO INSTALL CONSUMERS ENERGY COMPANY METER SOCKET, SUPPORT, SERVICE SWITCH AND OTHER EQUIPMENT REQUIRED TO PROVIDE POWER TO PROPOSED EQUIPMENT AFTER THE UTH DATE NO. REVISION CONTACT: JON LOIACANO, CONSUMERS ENERGY, PHONE METER. LOCATE METER SOCKET AS DIRECTED BY ENGINEER. SERVICE TO METER SOCKET, SERVICE CONNECTION AND METER INSTALLATION (989) 366-4227 FOR ELECTRICAL SERVICE TO ROADSIDE WILL BE COMPLETED BY CONSUMERS ENERGY AT NO COST TO DYNAMIC MESSAGE SIGNS. NO COST TO CONTRACTOR CONTRACTOR. WORK REQUIRED TO PROVIDE ELECTRICAL SERVICE IS INCLUDED IN PAY ITEM Dynamic Message Sign, Large ITS, Ground Mounted WITH Cellular Modem
PLACE CABINET APPROXIMATELY 20' TO 30' IN FRONT OF SIGN TO ALLOW CLEAR VIEW OF SIGN FROM CABINET LOCATION CAUTION - CRITICAL UNDERGROUND UTILIT PROPOSED LOCATION OF SB DMS SIGN I-75 SB SURVEY & STA 1159+75, 65.87' LT MDOT WILL MARK LOCATION IN FIELD EX HMA SHOULDER EX HMA OVER RUBBLIZED CONCRETE PAVEMENT , 1159 , 1155 1157 1154  $\overline{\Box}$  $\Leftrightarrow$ EX HMA SHOULDER APPROXIMATE I-75 SB SURVEY & **├** A — APPROXIMATE I−75 SB CONSTRUCTION € 36" RADIUS PLASTIC BEND PLAN BOLT PATTERN TO MANUFACTURES NO. & SIZE AS REQUIRED SPECIFICATIONS (AS REQUIRED FOR CABINET) TO COMPLETE INSTALLATION -PROPOSED LOCATION OF SB DMS SIGN I-75 SB SURVEY € STA 1159+75±, 65.87′ LT APPROXIMATE I-75 SB SURVEY C--APPROXIMATE I-75 SB CONSTRUCTION & 1 1 1 11 1 1 1 1 11 1 1250 1250 1240 1240 26" MIN. GROUND WIRE 28" MIN. 1230 1230 <u>PLAN</u> 1220 1220 100 90 80 60 20 10 20 50 3/4" X 42" FOUNDATION ENDS (TYP.) BOLTS (AS REQUIRED FOR CABINET) #2 OR LARGER STRANDED COPPER GROUND -WIRE WITH 18" SLACK ABOVE FOUNDATION HOIZ 1"=10' VERT 1"=10' III III SECTION A-A 1 101 11 1 I III II Total II I 1 101 11 1 I Int It I CONSTRUCTION QUANTITES 1 111 11 1 1 Ea Dynamic Message Sign, Large し川しし 1 Ea Dynamic Message Sign, Large, Support Structure SOLDERLESS TYPE CLAMP 35 Ft Dynamic Message Sign, Large, Foundation BOTTOM END OF ANCHOR 1 Ea Cabinet, ITS, Ground Mounted BOLTS SHALL POINT TOWARD CENTER OF FOUNDATION 1 Fa Cellular Modem 1 Ea Controller Fdn, Base Mount 3/4" X 10'-0" COPPER CLAD GROUND ROD MISCELLANEOUS DETAILS ELEVATION I-75 SB DMS SIGN LOCATION DETAILS CONTROLLER FOUNDATION, BASE MOUNT (N.T.S.) PARSONS BRINCKERHOFF, INC. MDOT 6015 W. ST. JOSEPH, SUITE 101 DESIGN UNIT | SHEET NO. | R.O. W | CONST. CONT. SEC. JOB NO. LANSING, MICHIGAN 48917 517-886-7416 07/10/06 1"=40" 20014

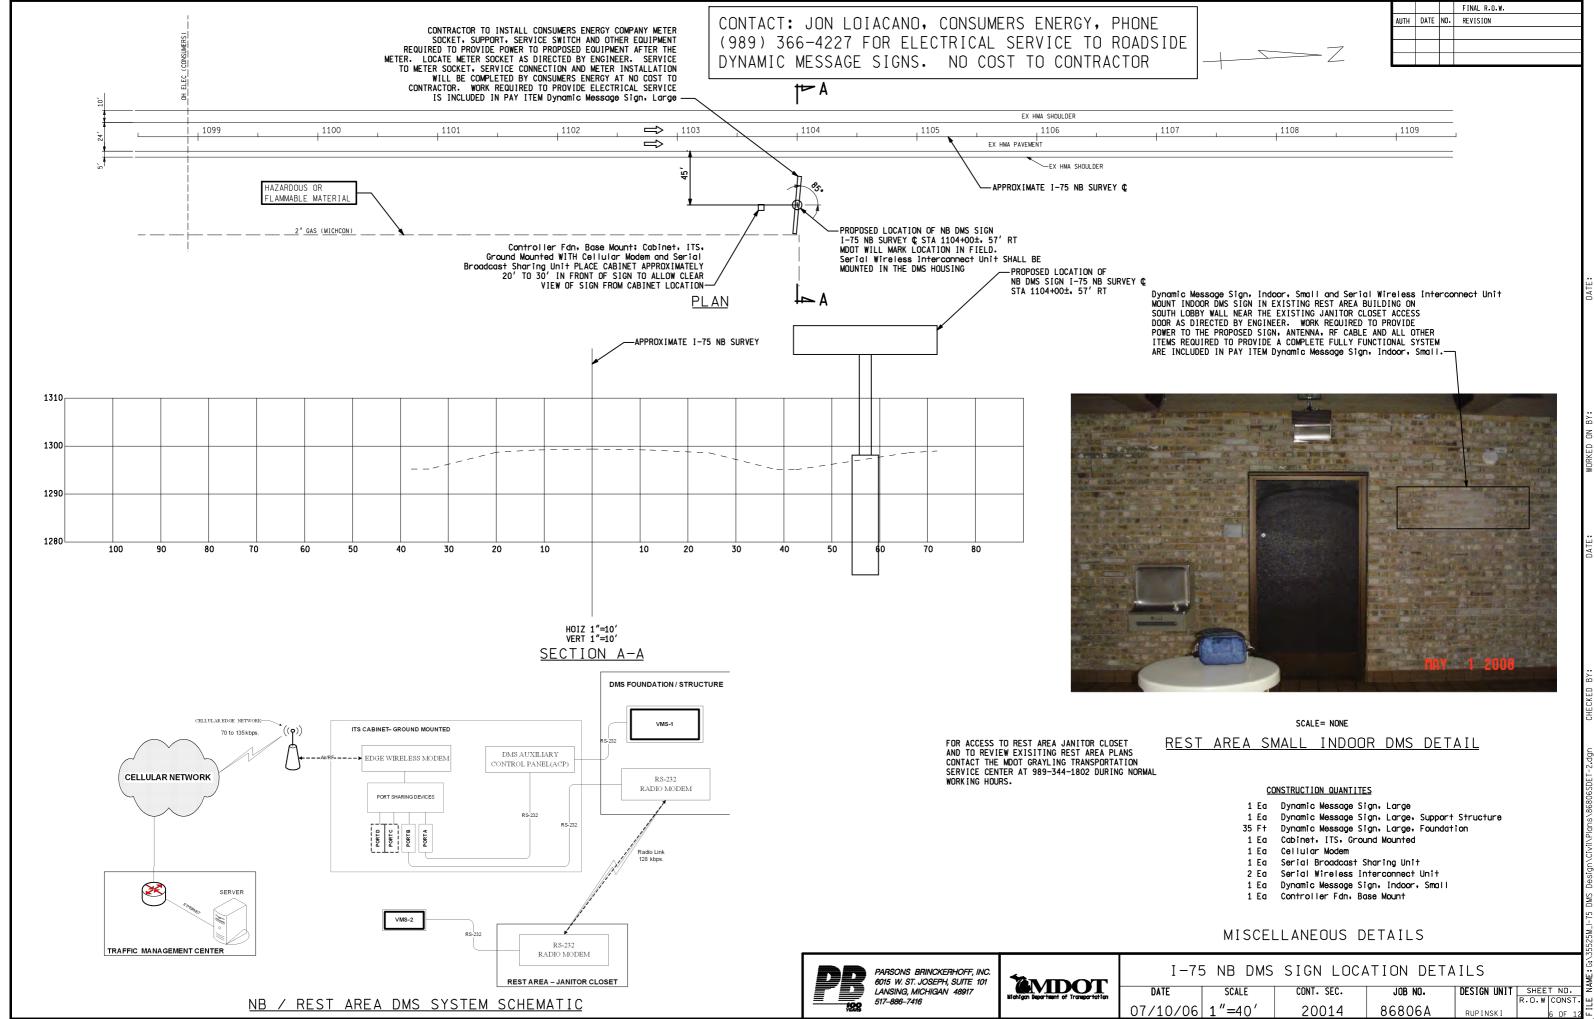


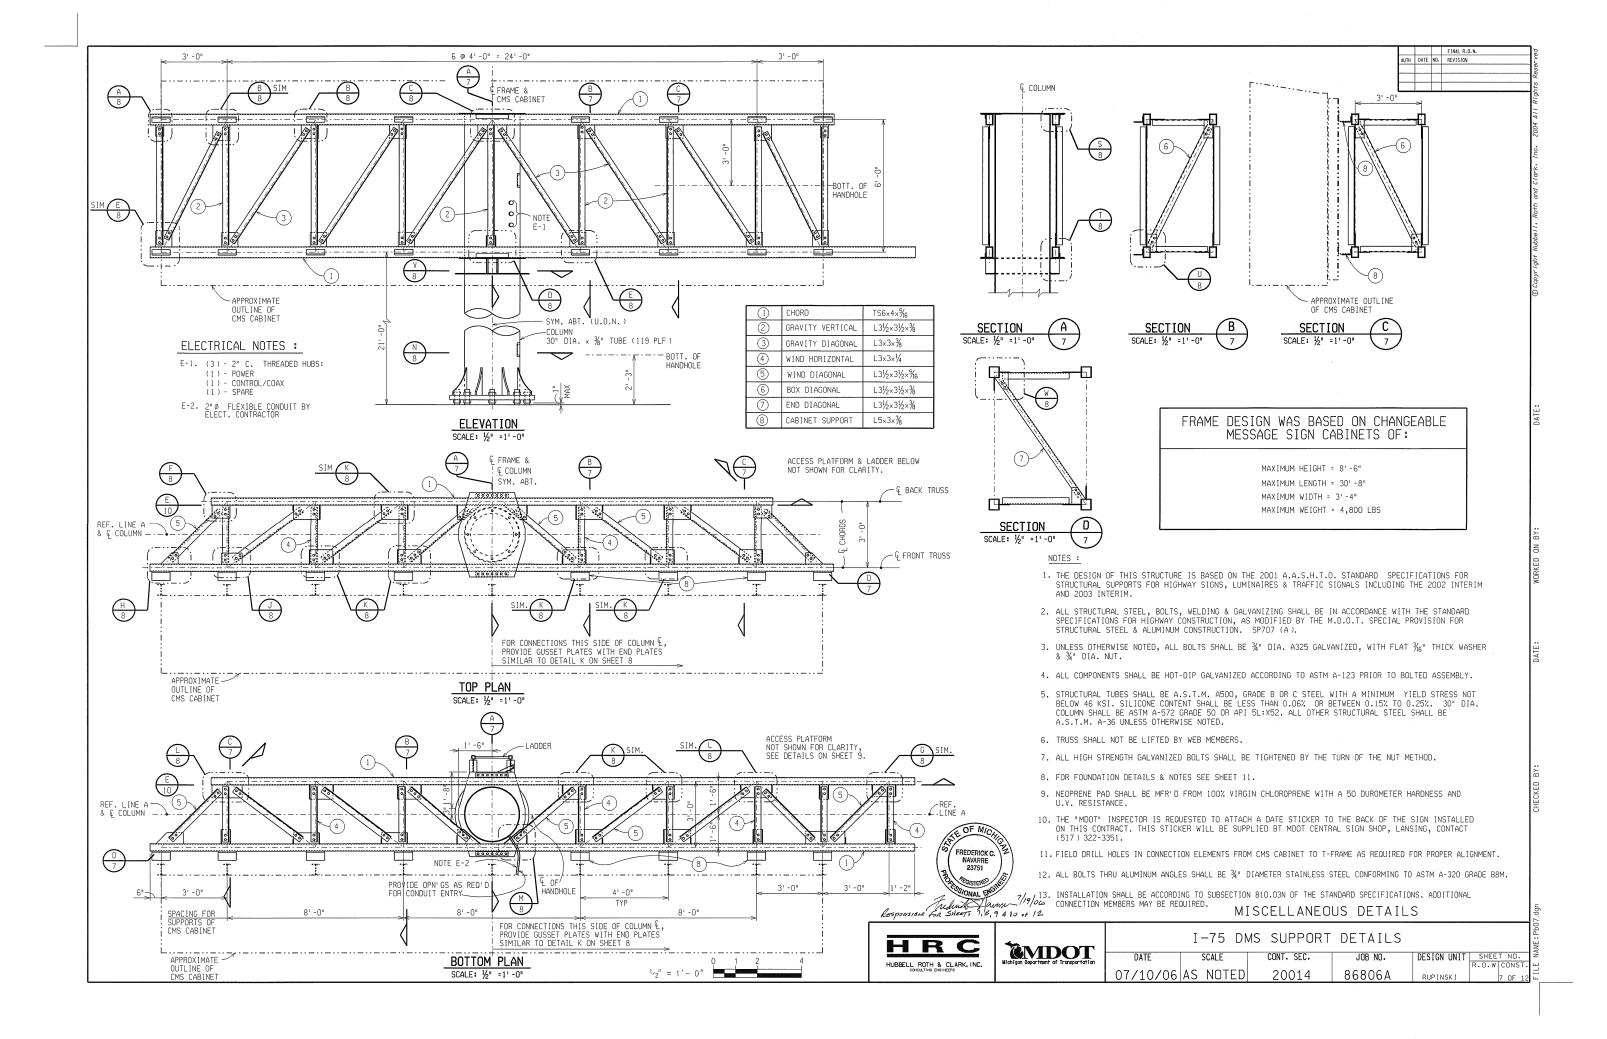

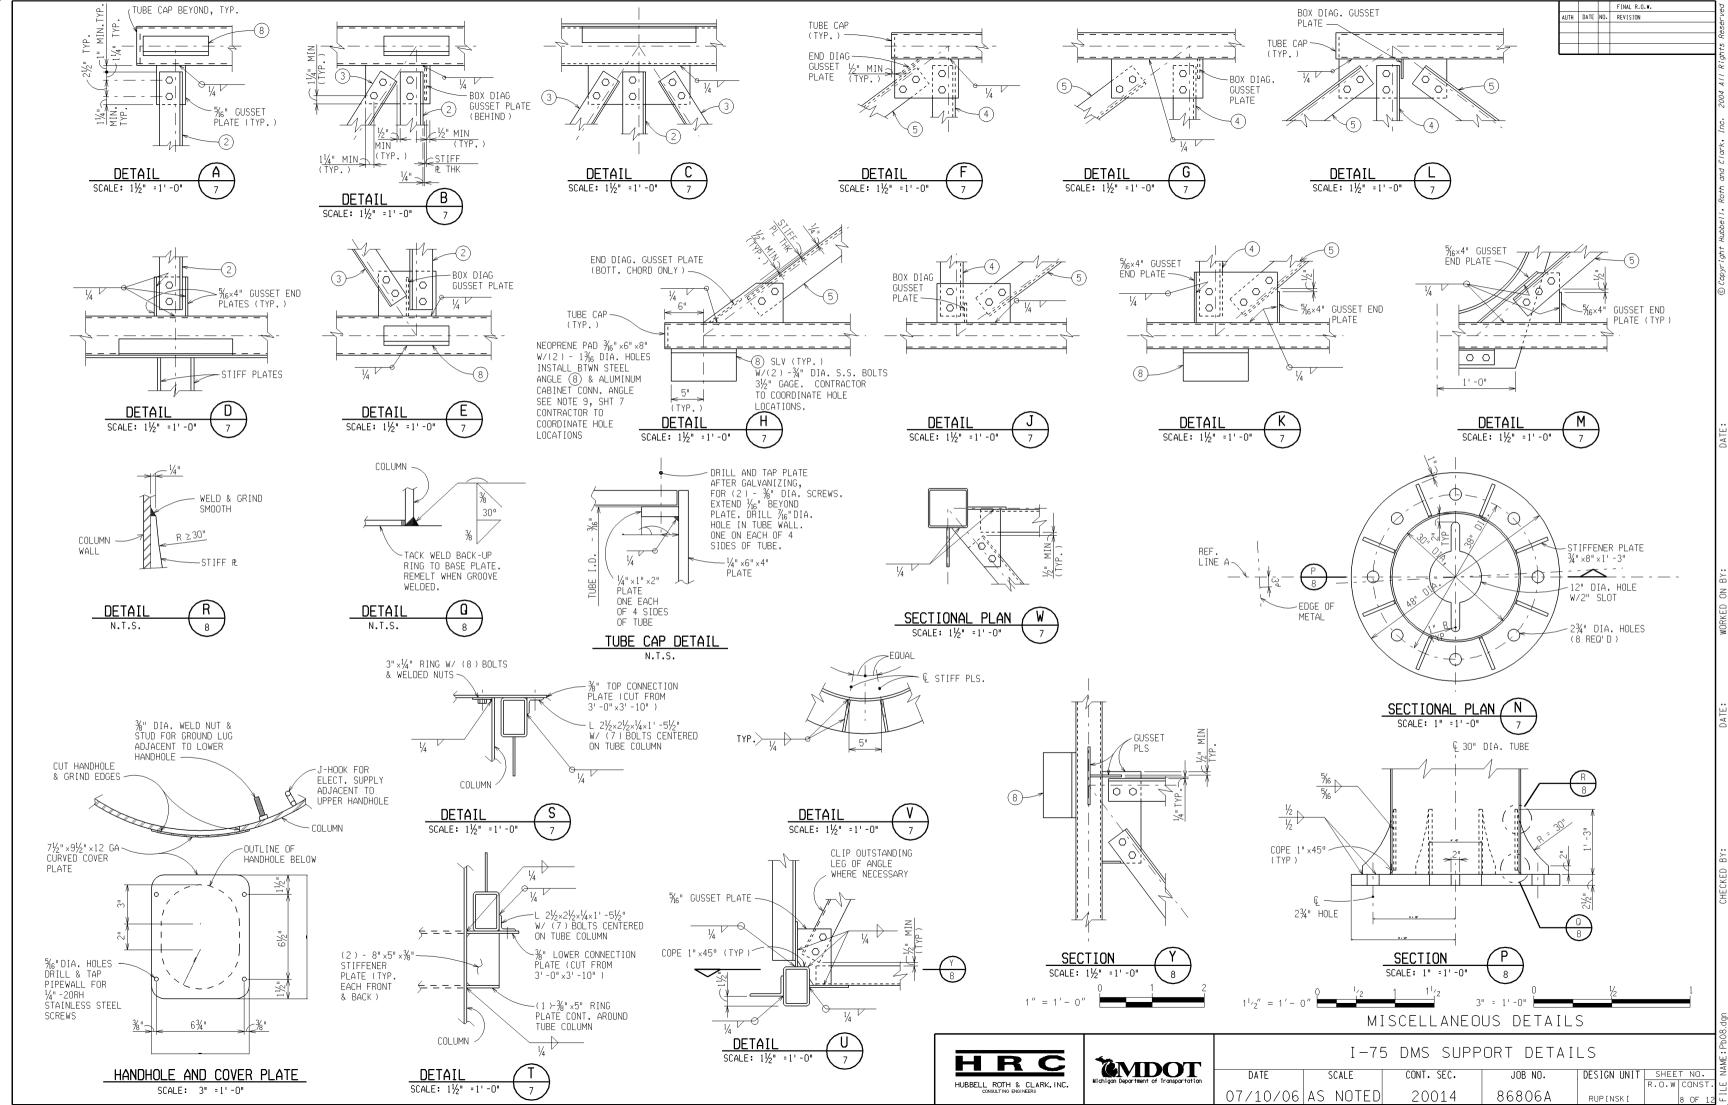


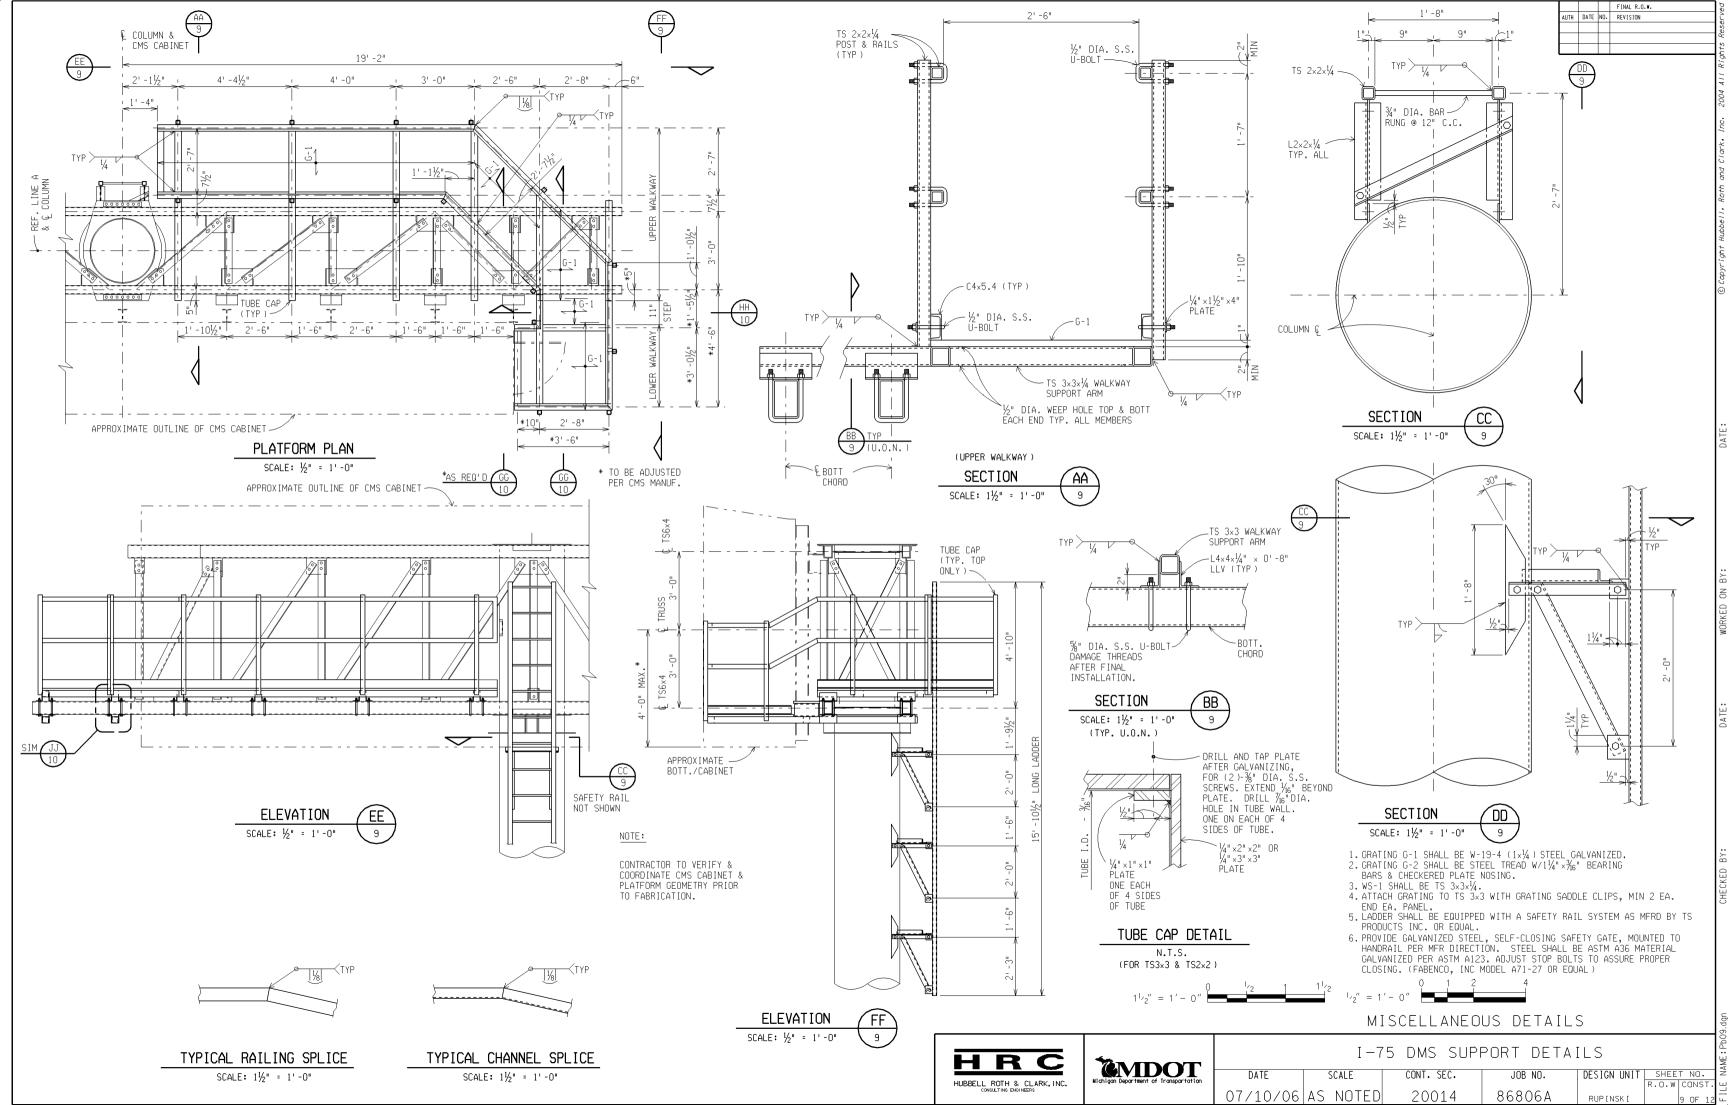

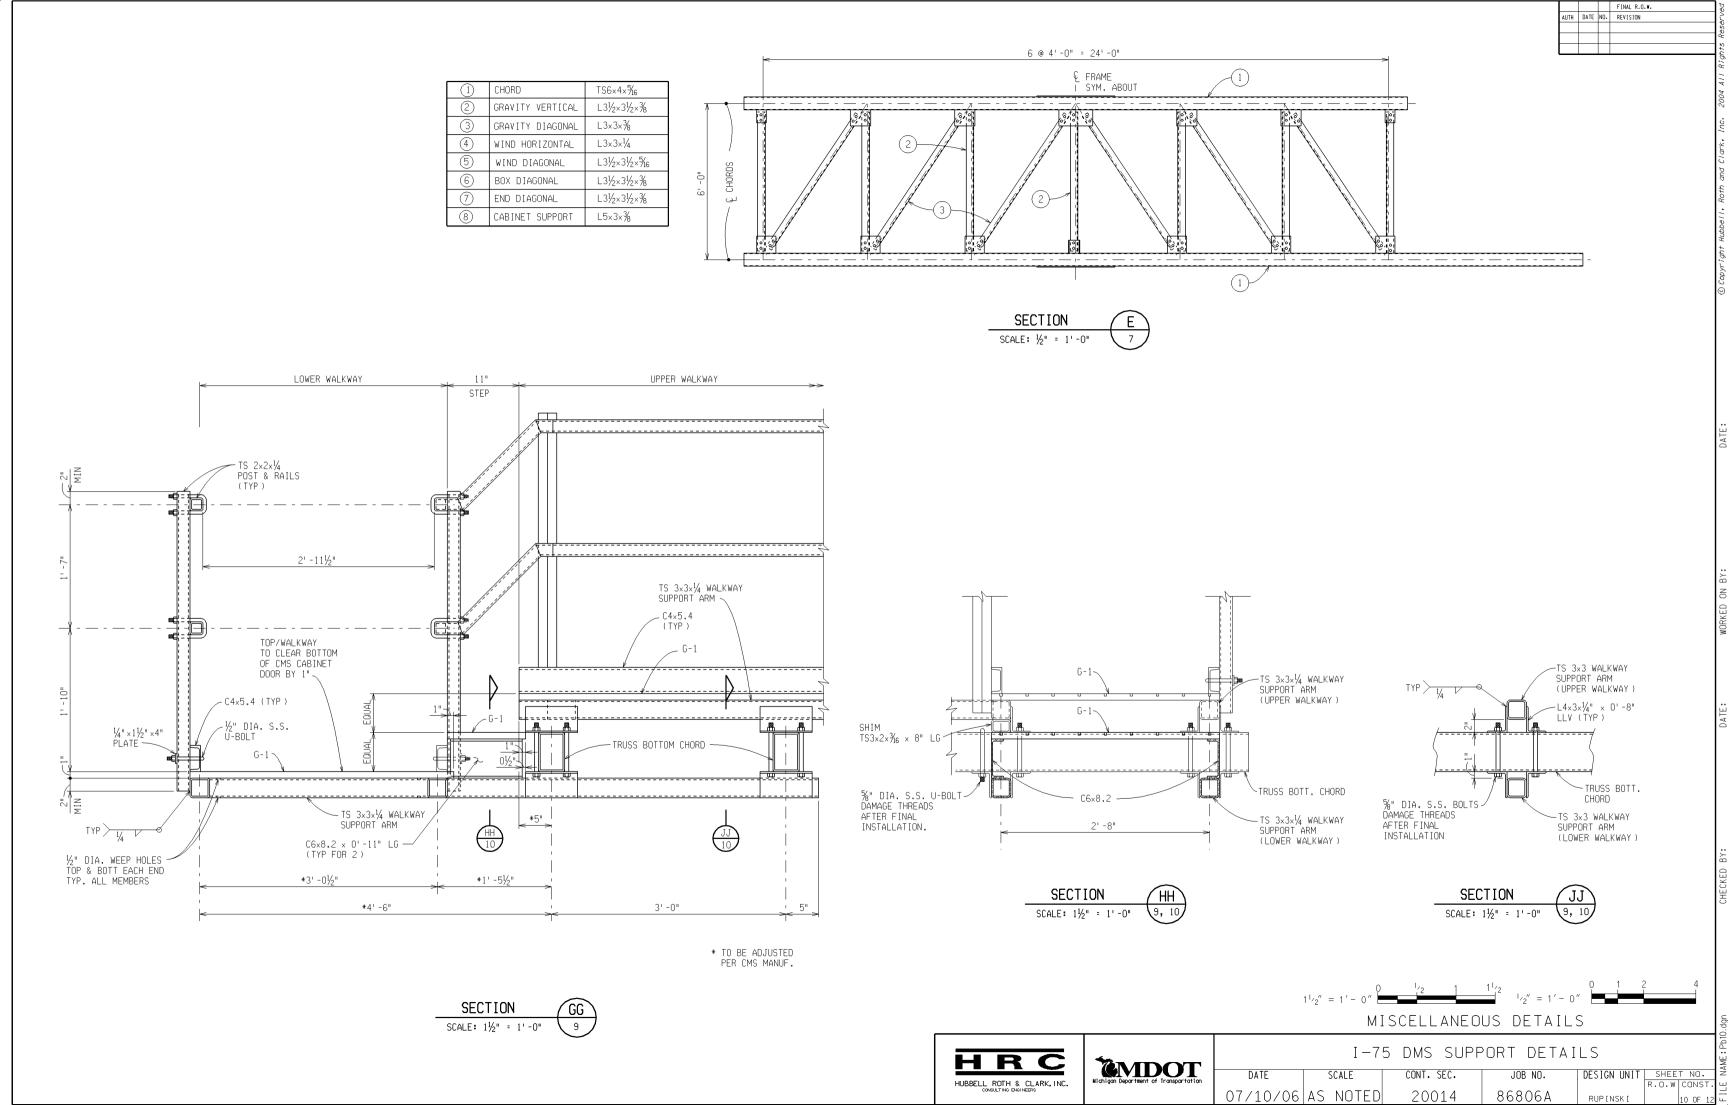

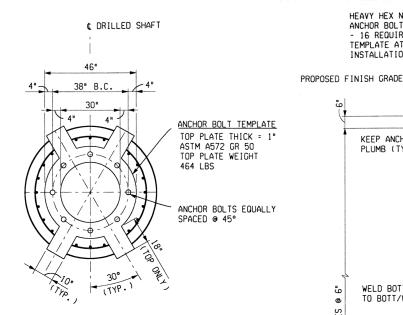

# ANCHOR BOLT TOP TEMPLATE LAYOUT PLAN

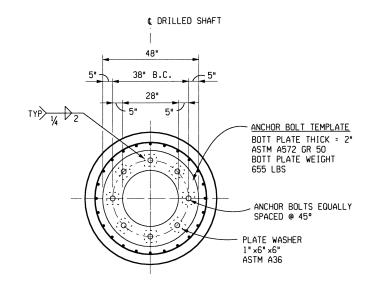

ANCHOR BOLT BOTTOM TEMPLATE LAYOUT PLAN

¢ DRILLED SHAFT

........

Massassia

ELECTRICAL CONDUIT INSTALLATION

PARTIAL ELEVATION\*

\*DESIGNED BY PARSONS BRINCKERHOFF, INC.

- COUPLING (TYP.)

P.V.C. CONDUIT

QUANTITY, SEE

FOR SIZE &

→ PLANS (TYP)

- EXOTHERMIC WELD

#2 BARE COPPER

GRD. CONDUCTOR

-¾"ø × 10'-0" LG.

IN 1" CONDUIT

COPPER CLAD

GROUND ROD

TO GROUNDING LUG-

# NOTES :

HEAVY HEX NUTS FOR

ANCHOR BOLTS - 16 REQUIRED PER

KEEP ANCHORS

PLUMB (TYP.

WELD BOTT NUT

TO BOTT/WASHER

VERTICAL STEEL

REINFORCEMENT

TEMPLATE AT

INSTALLATION

1. ALL MATERIALS & CONSTRUCTION SHALL CONFORM TO THE REQUIREMENTS OF THE MDOT 2003 STANDARD SPECIFICATIONS FOR CONSTRUCTION AND THE SPECIAL PROVISION FOR DYNAMIC MESSAGE SIGN, LARGE -DYNAMIC MESSAGE SIGN, LARGE, SUPPORT STRUCTURE-DYNAMIC MESSAGE SIGN, LARGE, FOUNDATION.

#10-1-61-1-60#

#17-1-----

**ᠬ**/ᢇ ᢇ ᢇ ᠇ ᢇ ᢇ ┈

#17-1-617-1-61

 $\#\square\square\square\square\square\square\square\square\square\square\square$ 


SECTION A-A

- 2. FOUNDATION CONCRETE SHALL BE GRADE S2.
- 3. TOP OF DRILLED SHAFT FOUNDATION SHALL BE 3" ABOVE FINISHED GRADE.
- DRILLED SHAFT FOUNDATION SHALL RECEIVE RUBBED SURFACE FINISH FROM TOP OF FOUNDATION TO 6" BELOW GRADE.
- 5. SUBSURFACE AND GROUNDWATER INFORMATION CAN BE OBTAINED FROM



# 5' -6" ANGLE, SEE ION DETAILS 2' -9" ANCHOR EDGE OF

**PLAN** 

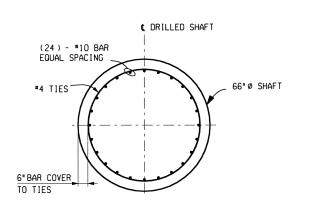

SECTION B-B SEE SHEET 11

# STEEL REINFORCEMENT SCHEDULE NUMBER WE I GHT MARK SIZE DIMENSIONS REO'D. (LBS. 34' -6" 24 3563 A103406 14' -2"

FINAL R.O.W.

Cu. Yd.

31

69

699

REINF.

4262

REVISION

AUTH DATE NO.

" D"

35' -0"

DRILLED SHAFT INFORMATION

DYNAMIC MESSAGE SIGN

SEE PLAN SHEET 7 FOR

DMS TYPES


V041502

STEEL REINFORCEMENT TOTAL WEIGHTS (LBS.)

# REINFORCEMENT BAR & ANCHOR BOLT NOTES:

- 1. REINFORCEMENT BARS FOR FOUNDATION SHALL BE GRADE 60 DEFORMED BARS AS SPECIFIED IN SECTION 905.03 OF THE MDOT 2003 STANDARD SPECIFICATIONS FOR CONSTRUCTION.
- 2. ANCHOR BOLTS ARE TO BE VERTICAL & POSITIONED AS SHOWN IN
- 3. TEMPLATE PLATES & ANCHOR BOLT CAGE SHALL BE SHOP FABRICATED, ASSEMBLED, AND APPROVED BY MDOT PRIOR TO SHIPPING.
- 4. DIAMETER OF BOLT HOLES IN TEMPLATES SHALL BE 1/16" LARGER THAN 5. INSTALLATION SHALL BE ACCORDING TO SUBSECTION 810.03N OF THE
- STANDARD SPECIFICATIONS. 6. THE TEMPLATES & HANDLES SHALL BE WELL SUPPORTED, HORIZONTALLY LEVEL & FIRMLY ANCHORED IN PLACE FOR A MINIMUM OF 24 HOURS AFTER
- THE CONCRETE PLACEMENT IS COMPLETED. 7. DUE CARE SHALL BE TAKEN DURING THE CONCRETE PLACEMENT TO AVOID
- 8. NO HAMMERING ON THE ANCHOR BOLTS OR TEMPLATES WILL BE ALLOWED. NO CHISELING OR DAMAGING OF GALVANIZED FINISH WILL BE PERMITTED.
- AFTER TOP TEMPLATE IS REMOVED, THREAD NUTS ON TO THE BOLT FLUSH WITH THE BOLT END TO PROTECT THREADS UNTIL FRAME IS ERECTED.

# ANCHOR BOLT TABLE

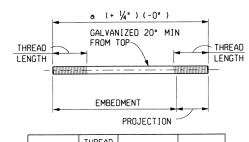

a	THREAD LENGTH EA END	PROJECTION	SIZE	
10' -0"	11"	10½"	2½" ø	

ANCHOR BOLTS:  $2\frac{1}{2}$ " Ø (8UN SERIES THREAD), (8) PER FOUNDATION.

(4) - 2½"Ø PER ANCHOR BOLT

WASHERS: (2) - 21/2" Ø STANDARD FLAT PER ANCHOR

ANCHOR BOLTS, NUTS, AND WASHERS SHALL BE IN ACCORDANCE WITH SECTION 908.15 A&B OF THE MDOT "2003 STANDARD SPECIFICATIONS FOR CONSTRUCTION"

# THE SOIL BORING DATA PLAN SHEET.

6. ALL DISTURBED AREAS SHALL BE RESTORED IN ACCORDANCE WITH THE SPECIAL PROVISION FOR SLOPE RESTORATION, FREEWAY. CONTRACTOR IS TO MINIMIZE THE AREAS OF DISTURBANCE AS MUCH AS IT IS PRACTICABLE.

# Wilcox Professional Services



LIMITS OF RUBBED

SURFACE FINISH

PS /

CASING

1½" CHAMFER

AN ANCHOR BOLT CAGE SHALL BE SHOP FABRICATED FROM #6 BAR CIRCLE OR

34" SQUARE STOCK OR

APP'D EQUAL WELDED

TO THE INSIDE OF ANCHOR BOLTS TO HOLD ALIGNMENT.

4 B

PARSONS BRINCKERHOFF, INC. 6015 W. ST. JOSEPH, SUITE 101 LANSING, MICHIGAN 48917 517-327-7848

DISPLACING THE ANCHOR BOLTS.

**EMDOT** 

DMS FOUNDATION DETAILS DESIGN UNIT SHEET NO. SCALE CONT. SEC. R.O.W. CONST. 07/10/06 NONE 20014 86806A

		TEST HOLE NO.1				
LOCATION STATION: 1104+00.0 45.0 ft RT OF I-75 NB RT EOM 1-75 NB DYNAMIC MESSAGE SIGN GROUND SURFACE ELEVATION: 1298.68 ft						
1298.68		LOOSE SILTY SANDY TOPSOIL				
1297.7		2002 01211 011101 101 0012				
1293.7	2 3 4					
1288.7	3 3 4	LOOSE BROWN FINE & MEDIUM SAND, TRACE FINE GRAVEL				
1283.7	3 3 4					
1280.7						
1278.7	3 7 9					
1273.7	3 8 11	MODERATELY COMPACT BROWN FINE &				
1268.7	3 10 14	MEDIUM SAND, TRACE FINE GRAVEL				
1263.7	4 12 15					
1260.7						
1258.7	5 12 30					
1253.7	5 16 21					
1248.7	6 22 27	COMPACT BROWN FINE & MEDIUM SAND				
1243.7	5 18 23					
1238 <b>.</b> 7 1237 <b>.</b> 2	5 17 20	E.O.B. 61.5 ft				
BOF	RING DATE	5/8/06				
WAT AUC	TER LEVEL GERS OUT:	L BELOW GROUND AFTER COMPLETION; DRY				

			FINAL K.U.W.
AUTH	DATE	NO.	REVISION

		-	TEST HOLE NO.2	TEST HOLE NO.3			
	24 <b>.</b> Ø f I-75 S	t LT OF	i: 1159+74.0 F I-75 SB LT EOM C MESSAGE SIGN E ELEVATION:1222.42 ft	LOCATION STATION: 1159+74.0 45.0 ft LT OF 1-75 SB LT EOM I-75 SB DYNAMIC MESSAGE SIGN GROUND SURFACE ELEVATION: 1228.09 ft			
				1228.89 1227.6 SANDY TOPSOIL 1227.1 LOOSE BROWN FINE SAND WITH FINE GRAVEL LOOSE BROWN FINE & MEDIUM SAND			
	1222.42 1221.9		SANDY TOPSDIL	1223.1 E.O.B. 5.0 ft			
			MODERATELY COMPACT BROWN FINE &	BORING DATE 5/9/06			
	1217.4	7 10 11	MEDIUM SAND, TRACE FINE GRAVEL	WATER LEVEL BELOW GROUND AFTER COMPLETION; AUGERS OUT: DRY			
	1215.4						
	1212.4	1 4 4	LOOSE BROWN FINE & MEDIUM SAND				
	1209.4						
	1207.4	57					
	1202.4	256	MODERATELY COMPACT BROWN FINE &				
	1197.4	158	MEDIUM SAND				
	1192.4	2 6 12					
	1189.4	6					
	1187.4	18 23	COMPACT BROWN FINE & MEDIUM SAND				
	1184.4	4					
	1182.4	10 16					
	1177.4	5 12 17	MODERATELY COMPACT BROWN FINE & MEDIUM SAND				
	1174.4						
	1172.4	5 15 22					
	1167.4	8 16 20	COMPACT BROWN FINE & MEDIUM SAND				
	1100 4	10		NOTES:			
	1162.4 1160.9	17 20	E.O.B. 61.5 ft	0 1st 6' 2nd 6' 3rd 6'			
	BOR	RING DATE	5/9/06	NUMBERS IN CIRCLES DENOTE NUMB			
WATER LEVEL BELOW GROUND AFTER COMPLETION; AUGERS DUT: DRY				(1½°I.D.)SPLIT SPOON SAMPLER 3 S HAMMER FALLING 30°. CONSISTENCY WAS DETERMINED BY			
	1			LUNDIDIENLI WAD DETERMINED BY			


NUMBERS IN CIRCLES DENOTE NUMBER OF BLOWS REQUIRED TO DRIVE A 2"O.D. (1½"I.D.)SPLIT SPOON SAMPLER 3 SUCCESSIVE 6"INCREMENTS USING A 140" HAMMER FALLING 30".

CONSISTENCY WAS DETERMINED BY INSPECTION OF SAMPLES AND SUBSTANTIATED BY SOILS RESISTANCE TO DRILLING TOOLS.

THE SOIL BORING LOGS REPRESENT POINT INFORMATION. PRESENTATION OF THIS INFORMATION IN NO WAY IMPLIES THAT SUBSURFACE CONDITIONS ARE THE SAME AT LOCATIONS OTHER THAN THE EXACT LOCATION OF THE BORING.

86806A




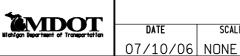


	LOG	OF	ВС	DRINGS	
SCALE	COI	NT. SEC.		JOB NO.	

20014

DESIGN UNIT SHEET NO.
R.O.W CONST.
RUPINSKI 12 OF 12

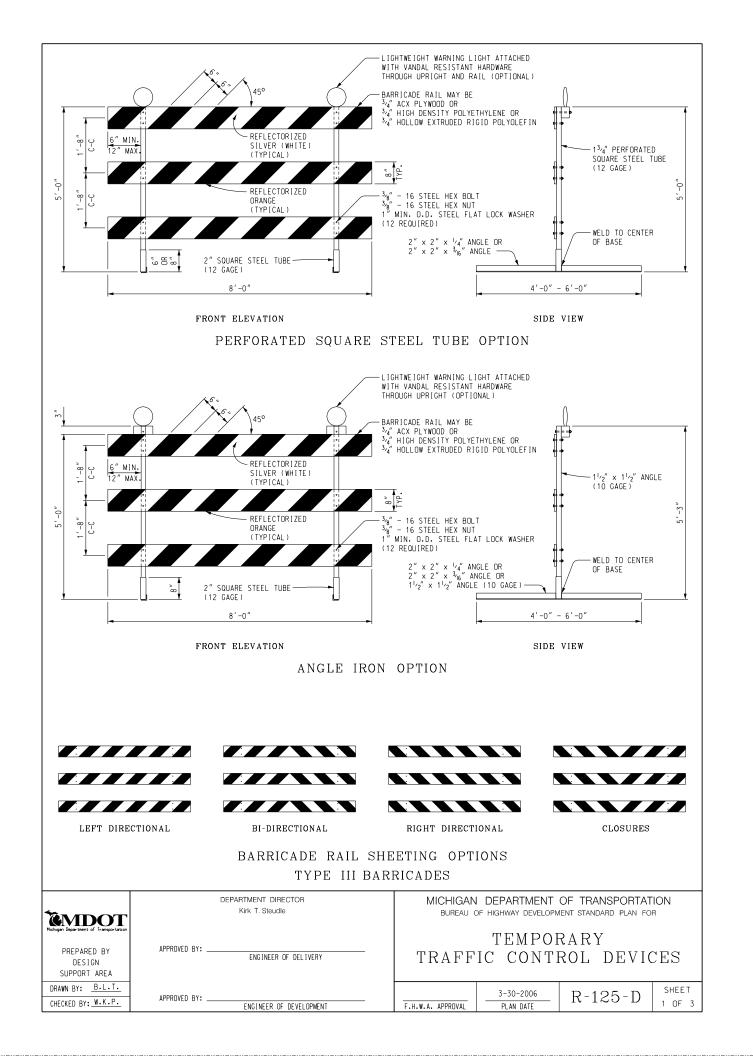

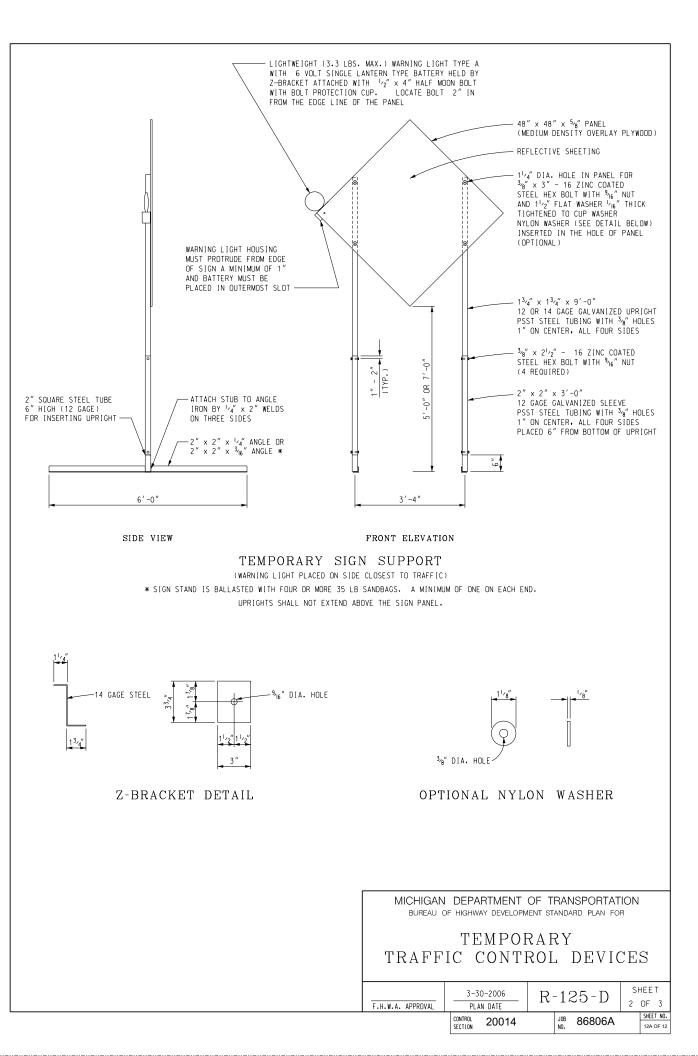




PLASTIC DRUM

▲ ▲ PROPOSED TYPE III BARRICADE

A A EXISTING TYPE III BARRICADE

# SYMBOLS TO BE USED ON PLANS

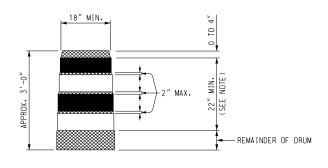

REFLECTORIZED ORANGE

REFLECTORIZED WHITE

NON REFLECTORIZED ORANGE

NOTE:
DRUMS SHALL HAVE AT LEAST 4 HORIZONTAL REFLECTORIZED
STRIPES (2 ORANGE AND 2 WHITE) OF 4" TO 6" UNIFORM
WIDTH. ALTERNATING IN COLOR WITH THE TOPMOST
REFLECTORIZED STRIPE BEING ORANGE. NON REFLECTORIZED
SPACES BETWEEN THE HORIZONTAL REFLECTORIZED ORANGE
AND WHITE STRIPES SHALL BE ORANGE IN COLOR AND EQUAL
IN WIDTH.

# PLASTIC DRUM

### NOTES:

 $2\,^{\prime\prime}$  PERFORATED SQUARE STEEL TUBES. MAY BE USED TO FABRICATE THE HORIZONTAL BASE OF THE TYPE III BARICADE.

WARNING LIGHTS SHALL BE PLACED ACCORDING TO THE CURRENT STANDARD SPECIFICATIONS WHEN THEY ARE USED ON PLASTIC DRUMS OR TYPE !!!

SEE STANDARD PLANS R-113-SERIES AND R-126-SERIES FOR TYPICAL LOCATION AND SPACING OF PLASTIC DRUMS.

SIGNS, BARRICADES, AND PLASTIC DRUMS SHALL BE FACED WITH PRESSURE-SENSITIVE REFLECTIVE SHEETING ACCORDING TO THE CURRENT STANDARD SPECIFICATIONS.

SANDBAGS SHALL BE USED WHEN SUPPLEMENTAL WEIGHTS ARE REQUIRED TO ACHIEVE STABILITY OF THE BARRICADE. THE SANDBAGS SHALL BE PLACED SO THEY WILL NOT COVER OR OBSTRUCT ANY REFLECTIVE PORTION OF THE TRAFFIC CONTROL DEVICE.

MICHIGAN DEPARTMENT OF TRANSPORTATION BUREAU OF HIGHWAY DEVELOPMENT STANDARD PLAN FOR

# TEMPORARY TRAFFIC CONTROL DEVICES

SHEET 3-30-2006 R-125-D 3 OF 3 F.H.W.A. APPROVAL PLAN DATE

control section 20014

JOB 86806A

SHEET NO. 12B OF 12